
NEW BUILDING for

3685 MAIN STREET OAKLEY, CALIFORNIA

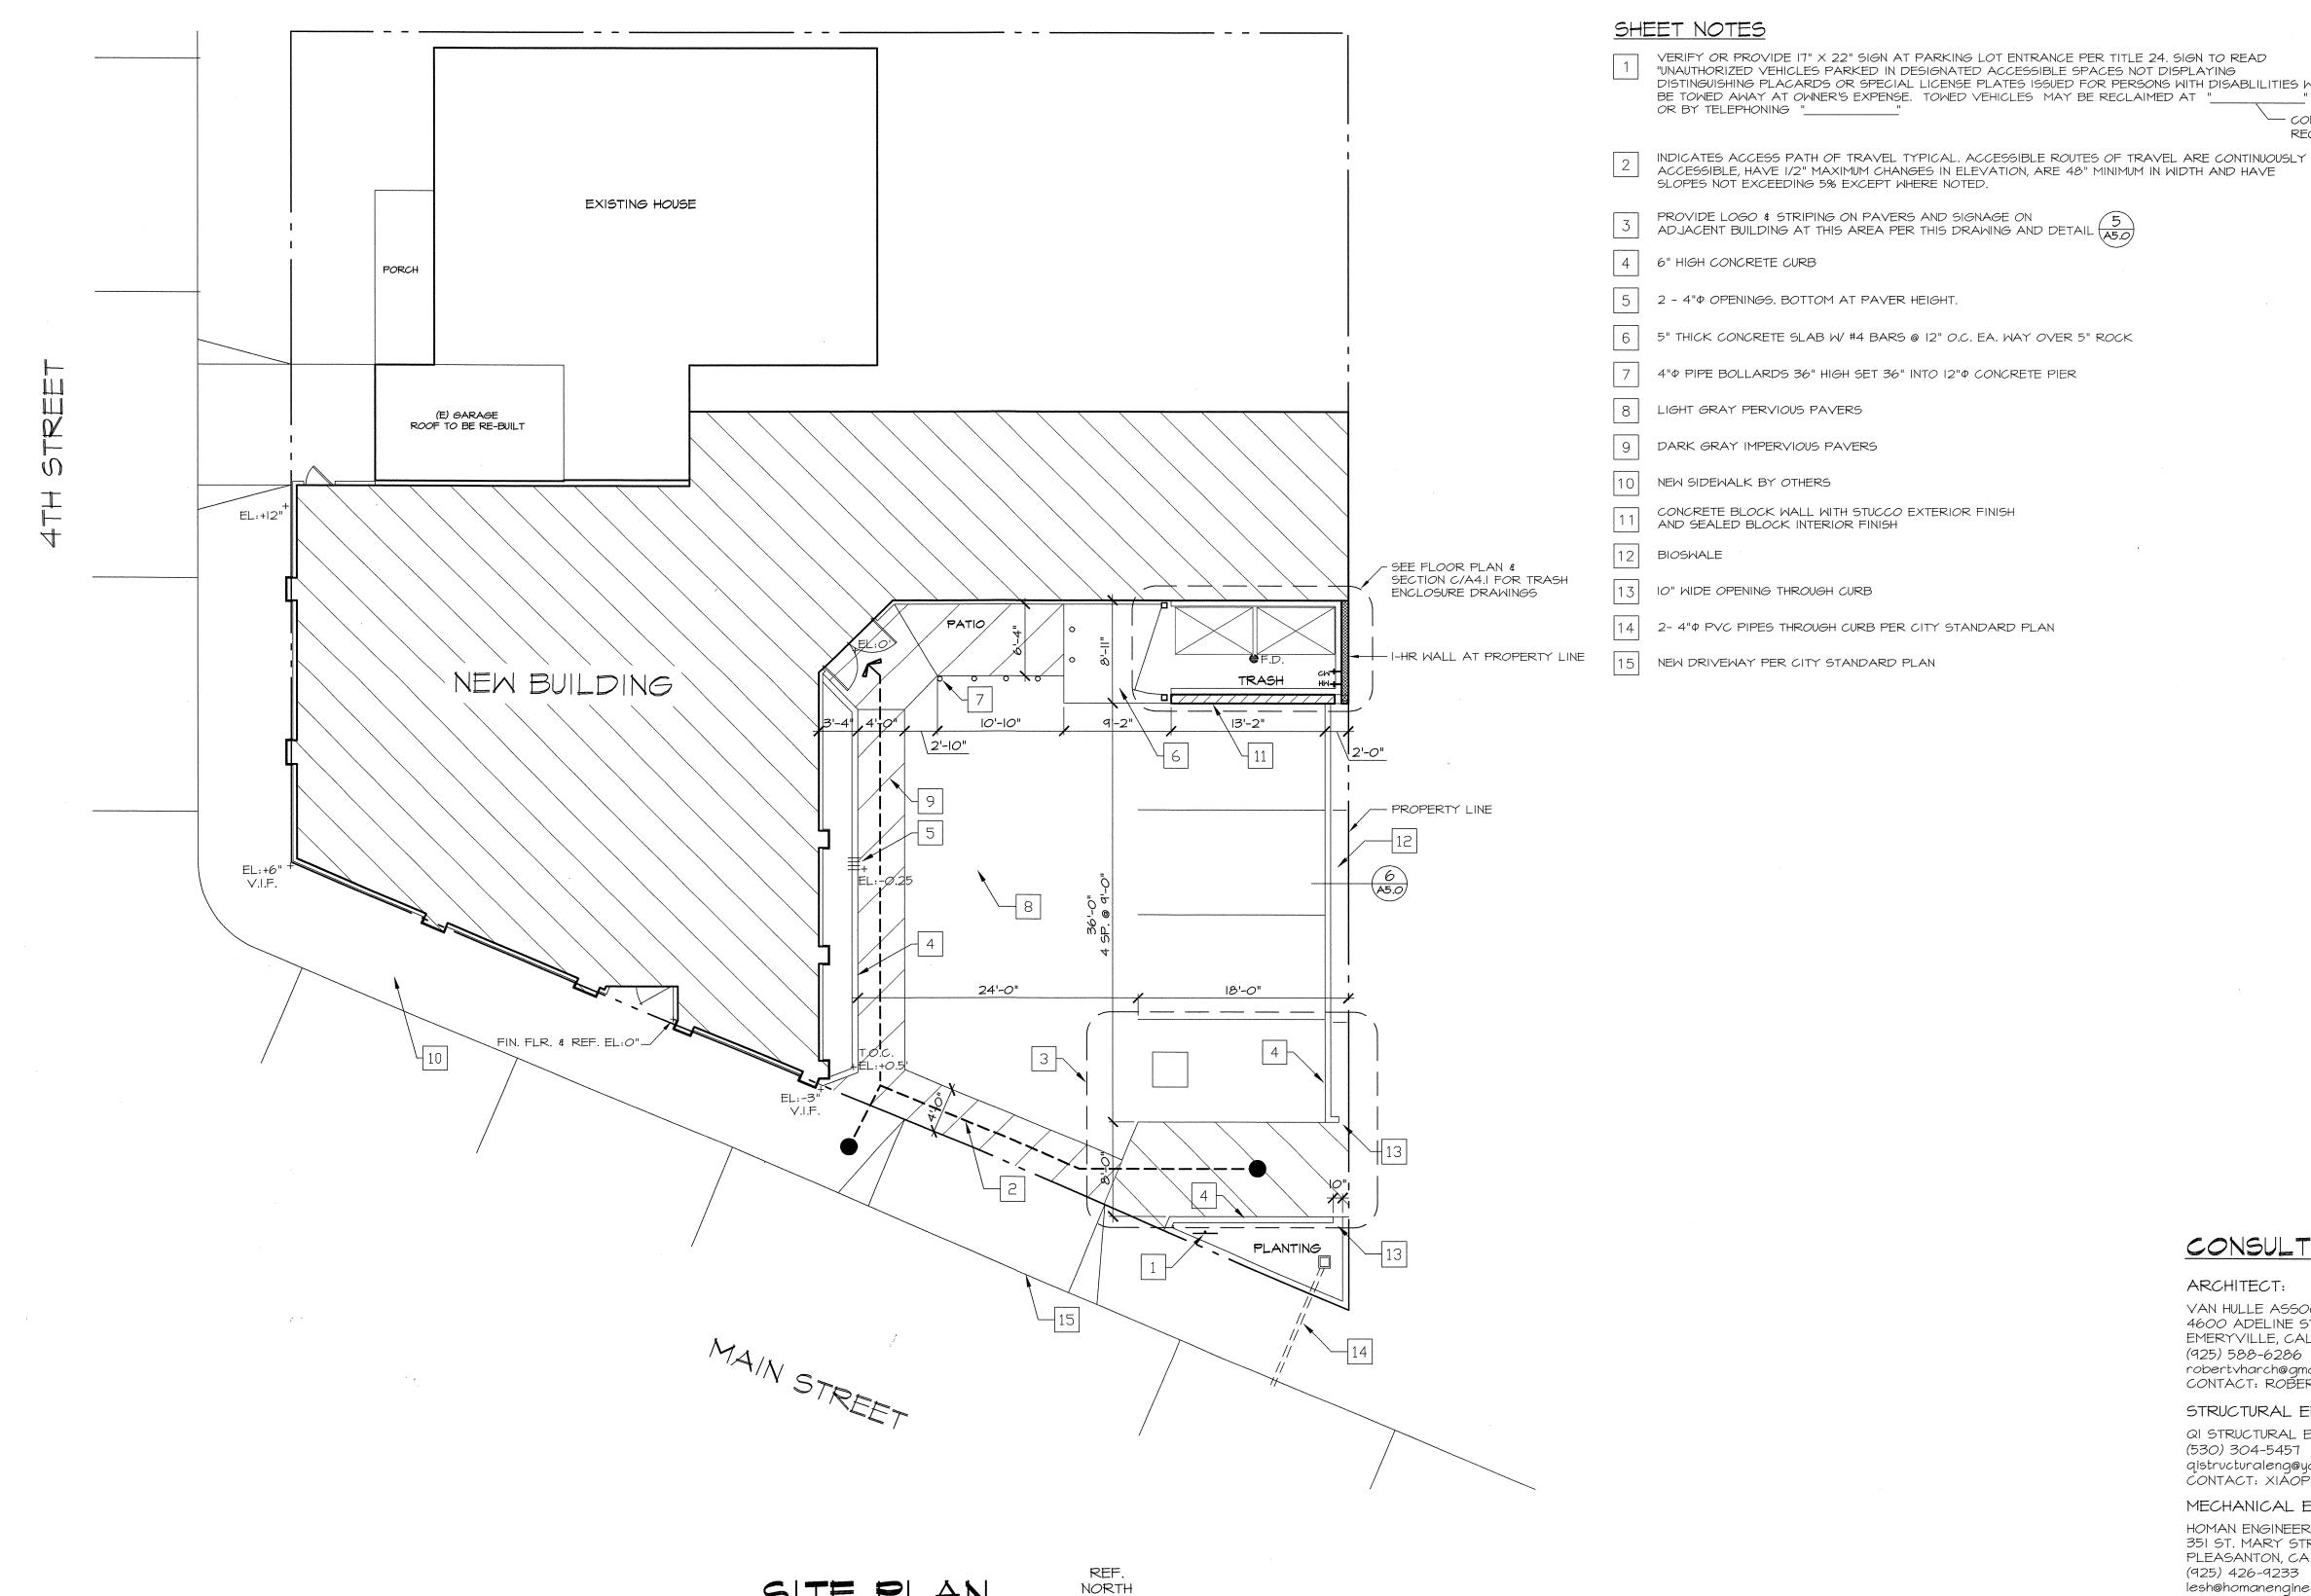

SITE PLAN

SCALE: 1/8" = 1'-0"

VERIFY OR PROVIDE 17" X 22" SIGN AT PARKING LOT ENTRANCE PER TITLE 24. SIGN TO READ "UNAUTHORIZED VEHICLES PARKED IN DESIGNATED ACCESSIBLE SPACES NOT DISPLAYING DISTINGUISHING PLACARDS OR SPECIAL LICENSE PLATES ISSUED FOR PERSONS WITH DISABLILITIES WILL BE TOWED AWAY AT OWNER'S EXPENSE. TOWED VEHICLES MAY BE RECLAIMED AT "_

> - CONTRACTOR TO PROVIDE REQUIRED INFORMATION (TYP)

ACCESSIBLE, HAVE 1/2" MAXIMUM CHANGES IN ELEVATION, ARE 48" MINIMUM IN WIDTH AND HAVE

PROVIDE LOGO & STRIPING ON PAVERS AND SIGNAGE ON

6 5" THICK CONCRETE SLAB W/ #4 BARS @ 12" O.C. EA. WAY OVER 5" ROCK

7 4" PIPE BOLLARDS 36" HIGH SET 36" INTO 12" CONCRETE PIER

CONSULTANTS

ARCHITECT:

VAN HULLE ASSOCIATES 4600 ADELINE STREET, STE. #204 EMERYVILLE, CALIFORNIA 94608 (925) 588-6286 robertvharch@qmail.com CONTACT: ROBERT VAN HULLE

STRUCTURAL ENGINEER:

QI STRUCTURAL ENGINEERING SERVICES (530) 304-5457 qistructuraleng@yahoo.com CONTACT: XIÃOPEI (CHAD) QI

MECHANICAL ENGINEER:

HOMAN ENGINEERING CORPORATION 351 ST. MARY STREET PLEASANTON, CA 94566 (925) 426-9233 FAX (925) 426-9313 lesh@homanengineering.com CONTACT: LEŚ HOMAÑ

ELECTRICAL ENGINEER:

GREWAL ENGINEERING ASSOCIATES, INC. AMERICAN CANYON, CA 94503 (707) 373-9451 pjgrewal@sbcglobal.net CONTACT: PJ GREWAL

GENERAL NOTES:

1. ALL WORK SHALL COMPLY WITH THE FOLLOWING: 2016 INTERNATIONAL BUILDING CODE AS AMENDED BY THE 2016 CALIFORNIA BUILDING CODE.

2016 NATIONAL ELECTRICAL CODE AS AMENDED BY THE 2016 CALIFORNIA ELECTRICAL CODE.

2016 UNIFORM MECHANICAL CODE AS AMENDED BY THE 2016 CALIFORNIA MECHANICAL CODE.

2016 UNIFORM PLUMBING CODE AS AMENDED BY THE 2016 CALIFORNIA PLUMBING CODE.

2016 INTERNATIONAL FIRE CODE AS AMENDED BY THE 2016

CALIFORNIA FIRE CODE. 2016 CALIFORNIA ENERGY CODE

2016 CALIFORNIA GREEN BUILDING STANDARDS CODE ALL OTHER APPLICABLE STATE AND LOCAL CODES AND ORDINANCES.

2. ALL WORK TO COMPLY WITH CURRENT TITLE 24 AND FEDERAL ADA ACCESSIBILITY STANDARDS.

WITH A MAXIMUM OPENING EFFORT OF 5 LBS.

3. CONTRACTOR SHALL THOROUGHLY REVIEW THESE PLANS AND EXISTING SITE CONDITIONS AND SHALL NOTIFY THE ARCHITECT OF ANY ERRORS, DISCREPANCIES, OR OMISSIONS PRIOR TO SUBMITTING A BID.

4. CONTRACTOR SHALL BE RESPONSIBLE FOR PERFORMING ALL WORK REQUIRED FOR A COMPLETELY FINISHED JOB.

5. ALL DOORS WITH LATCHES SHALL BE PROVIDED WITH LEVER HARDWARE. HARDWARE SHALL BE CENTERED BETWEEN 30" AND 44" ABOVE THE FLOOR AND ALL DOORS SHALL BE OPERABLE

PROJECT DATA:

BUILDING FLOOR AREA:

2,676 SQ. FT.

TYPE OF CONSTRUCTION: TYPE V-B, SPRINKLERED

OCCUPANCY GROUP: A-2

OCCUPANT LOADS:

WAITING 6 OCCUPANTS 75 OCCUPANTS DINING RM. 1123/15 PARTY RM. 13 OCCUPANTS 4 OCCUPANTS BAR & KITCHEN 731/200 98 OCCUPANTS

> 98 > 50 : TWO EXITS REQUIRED TWO EXITS PROVIDED

SHEET INDEX

SITE PLAN - NOTES FLOOR PLAN

REFLECTED CEILING PLAN

FINISH PLAN

EQUIPMENT PLAN

ROOF PLAN

EXTERIOR ELEVATIONS

SECTIONS

DETAILS DETAILS

DETAILS

STRUCTURAL NOTES

FOUNDATION PLAN

LATERAL/SHEAR WALL PLAN

ROOF FRAMING PLANS STRUCTURAL DETAILS

MECHANICAL GENERAL NOTES AND SCHEDULES

MECHANICAL DETAILS

MECHANICAL PLAN RCP

MECHANICAL PLAN HOOD DRAWINGS

HOOD DRAWINGS

HOOD DRAWINGS

HOOD DRAWINGS

MECHANICAL PLUMBING ROOF

PLUMBING GENERAL NOTES AND SCHEDULES PLUMBING WASTE - GAS AND ROOF DRAIN

PLUMBING WATER

T24.I-6 MECHANICAL TITLE 24


ELECTRICAL ABBREVIATIONS, SYMBOLS, NOTES


EO.2-6 ELECTRICAL T24 COMPLIANCE

ELECTRICAL SITE PLAN ELECTRICAL POWER PLAN

ELECTRICAL ROOF PLAN ELECTRICAL LIGHTING PLAN REVISIONS



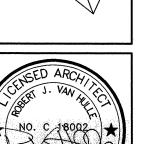

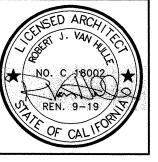



SITE PLAN -

DATE: 10/9/17

JOB NO: 1701 SCALE: AS NOTED

DRAWN BY: ST

SHEET:

SHEETS

